

New Verified Photomontages Part 4

Hinkley Point C Connection Project

*Regulation 5(2)(a) of the Infrastructure Planning
(Applications: Prescribed Forms and Procedure)
Regulations 2009*



Hinkley Point C Connection Project

Volume 8.7.3 – New Photomontages (orange highlight indicates the contents of this Volume)

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| 8.7.3.33 | VPG12 during operation |



Existing view
Existing view from Droveway Farm outside north elevation of property, looking north towards the F Route barely perceptible beyond garden boundary wall and trees (Section D)



Anticipated view during operation
Anticipated view of Sandford Substation and the 400kV overhead line supported by T-pylons during operation (with the F Route removed and tree removal not distinguishable)



Anticipated view during operation after 15 years
Anticipated view of Sandford Substation and the 400kV overhead line supported by T-pylons during operation, including mitigation planting after 15 years (with the F Route removed)

Viewing Information

This is a composite image made up of 4 No. 50mm photographs joined together horizontally to form an overall field of view which is wider than that seen in detail by the human eye.

For correct perspective viewing, this image must be viewed at an exact distance of 300mm with one eye whilst curving the image in an exact arc of 100 degrees. This image should only be assessed in the real landscape from the same viewpoint.

When not in the real landscape in order to provide an accurate representation images should be viewed with one eye by panning across a flat image with the eye remaining at the recommended viewing distance of 300mm from the image.

'This document relates to paragraph 5(2)(q) of the Infrastructure Planning (Applications: prescribed forms and procedure) Regulations 2009'

Light Detection and Ranging (LIDAR) level data typically at 40 points per/m2 and also data at 1m and 2m intervals was used for topographical information.

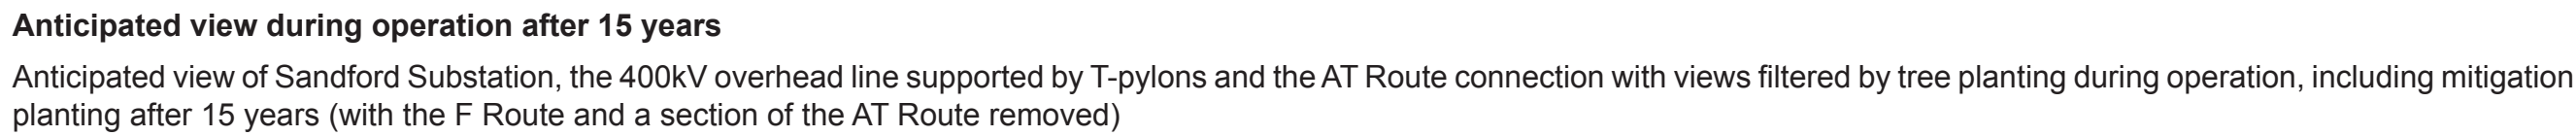
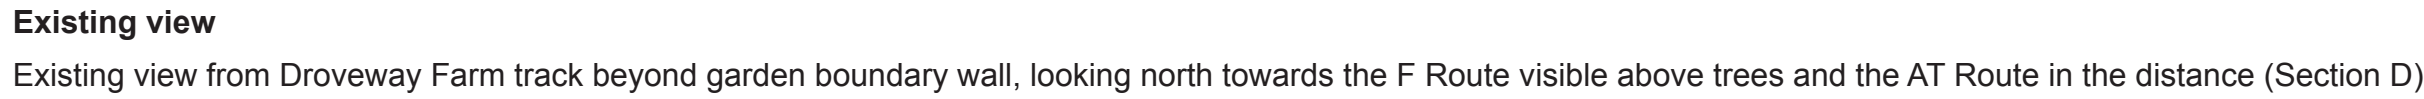
T-pylon

- Frame - light grey composite material, circular shape
- Insulator - light blue/grey composite material
- Twin conductor bundle

Steel lattice pylon

- Frame - grey steel material
- Insulator - light blue/grey composite material
- Twin conductor bundle

| | | | | | |
|--|--------------------|----------|------|------|-------|
| Date of photograph: 25/02/2015 Lens type:50mm (digital full frame camera) | | | | | |
| Distance to Sandford Substation boundary: 125m OS reference of viewpoint: X= 341833.866 Y= 160348.412 | | | | | |
| Direction of view: 303 ^o (north west) Viewpoint height: 16.842m AOD | | | | | |
| Horizontal field of view: 100 ^o Viewing distance approx 300mm at A1 | | | | | |
| | | | | | |
| A | 19/03/2015 | FRWG | AJG | LG | NH |
| ISSUE | DATE | COMMENTS | DRAW | CHKD | APPD |
| Title NATIONAL GRID (HINKLEY POINT C CONNECTION PROJECT) VOLUME 8.7.3 VERIFIED PHOTOMONTAGE VIEWPOINT VPD31 | | | | | |
| | | | | | |
| NSG INVESTMENT No. | APPLICATION No. | | | | IN |
| 20897 | EN020001 | | | | A1 |
| FIGURE No. | DRAWING No. | | | | SCALE |
| 8.7.3.25 | IN1979.82.025.001B | | | | NTS |
| SHEET 1 OF 1 | | | | | ISSUE |
| | | | | | A |



This is a composite image made up of 6 No. 50mm photographs joined together horizontally to form an overall field of view which is wider than that seen in detail by the human eye.

For correct perspective viewing, this image must be viewed at an exact distance of 300mm with one eye whilst curving the image in an exact arc of 140 degrees. This image should only be assessed in the real landscape from the same viewpoint.

When not in the real landscape in order to provide an accurate representation

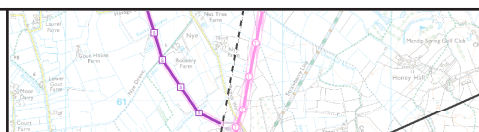




images should be viewed with one eye by panning across a flat image with the eye remaining at the recommended viewing distance of 300mm from the image.

'This document relates to paragraph 5(2)(q) of the Infrastructure Planning (Applications: prescribed forms and procedure) Regulations 2009'

Light Detection and Ranging (LIDAR) level data typically at 40 points per/m² and also data at 1m and 2m intervals was used for topographical information.

- Frame - light grey composite material, circular shape
- Insulator - light blue/grey composite material
- Twin conductor bundle

- Frame - grey steel material
- Insulator - light blue/grey composite material
- Twin conductor bundle

| <div>Date of photograph: 25/02/2015 Lens type: 50mm (digital full frame camera)</div> <div>Distance to Sanford Substation boundary: 77m OS reference of viewpoint: X= 341756.468 Y= 160355.158</div> <div>Direction of view: 324.8° (north east) Viewpoint height: 16.081m AOD</div> <div>Horizontal field of view: 140° Viewing distance approx 300mm at A1</div> |     <table><tr><th>ISSUE</th><th>DATE</th><th>COMMENTS</th><th>DRAW</th><th>CHKD</th><th>APPD</th></tr><tr><td>A</td><td>19/03/2014</td><td>FRWG</td><td>A/JG</td><td>LG</td><td>NH</td></tr></table> | ISSUE | DATE | COMMENTS | DRAW | CHKD | APPD | A | 19/03/2014 | FRWG | A/JG | LG | NH | <div><div>Title</div><div>NATIONAL GRID (HINKLEY POINT C CONNECTION PROJECT) VOLUME 8.7.3</div><div>VERIFIED PHOTOMONTAGE VIEWPOINT VPD33</div></div> <div><div> <small>National Grid plc, Windsor Training Park, Colnbrook, Uxbridge, Middlesex, UB8 3DA</small></div><table><tr><td>NG INVESTMENT No.</td><td>APPLICATION No.</td><td rowspan="2">IN</td></tr><tr><td>20897</td><td>ENO20001</td></tr></table><table><tr><td>FIGURE No.</td><td>DRAWING No.</td><td rowspan="2">SCALE NTS</td></tr><tr><td>8.7.3.26</td><td>IN1979.82.025.001B</td></tr></table><div>SHEET 1 OF 1</div><div>ISSUE A</div></div> | NG INVESTMENT No. | APPLICATION No. | IN | 20897 | ENO20001 | FIGURE No. | DRAWING No. | SCALE NTS | 8.7.3.26 | IN1979.82.025.001B |
|--|---|--------------|------|----------|------|------|------|---|------------|------|------|----|----|--|-------------------|-----------------|----|-------|----------|------------|-------------|--------------|----------|--------------------|
| ISSUE | DATE | COMMENTS | DRAW | CHKD | APPD | | | | | | | | | | | | | | | | | | | |
| A | 19/03/2014 | FRWG | A/JG | LG | NH | | | | | | | | | | | | | | | | | | | |
| NG INVESTMENT No. | APPLICATION No. | IN | | | | | | | | | | | | | | | | | | | | | | |
| 20897 | ENO20001 | | | | | | | | | | | | | | | | | | | | | | | |
| FIGURE No. | DRAWING No. | SCALE NTS | | | | | | | | | | | | | | | | | | | | | | |
| 8.7.3.26 | IN1979.82.025.001B | | | | | | | | | | | | | | | | | | | | | | | |



Existing view
Existing view from A369 The Portbury Hundred near the roundabout with Portbury Common and Sheepway, looking southeast towards the F Route and W Route across Clapton Moor and on Tickenham Ridge (Section F)



Anticipated view of preferred route (Option A) during operation
Anticipated view of the 400kV overhead line supported by T-pylons, visible on Tickenham Ridge during operation (with the F Route, W Route and eight trees removed)



Anticipated view of alternative route (Option B) during operation
Anticipated view of the 400kV overhead line supported by T-pylons, visible on Tickenham Ridge during operation (with the F Route, W Route and eight trees removed)

Viewing Information

This is a composite image made up of 5 No. 50mm photographs joined together horizontally to form an overall field of view which is wider than that seen in detail by the human eye.

For correct perspective viewing, this image must be viewed at an exact distance of 300mm with one eye whilst curving the image in an exact arc of 120 degrees. This image should only be assessed in the real landscape from the same viewpoint.

When not in the real landscape in order to provide an accurate representation images should be viewed with one eye by panning across a flat image with the eye remaining at the recommended viewing distance of 300mm from the image.

This document relates to paragraph 5(2)(a) of the Infrastructure Planning (Applications: prescribed forms and procedure) Regulations 2009

Light Detection and Ranging (LIDAR) level data typically at 40 points per/m2 and also data at 1m and 2m intervals was used for topographical information.

T-pylon

- Frame - light grey composite material, circular shape
- Insulator - light blue/grey composite material
- Twin conductor bundle

| | | | | | |
|--|--------------------|----------|------|------|-------|
| Date of photograph: 26/02/2015 Lens type:50mm (digital full frame camera) | | | | | |
| Distance to the nearest T-pylon on preferred route (Option A): 1435m Distance to the nearest T-pylon on alternative route (Option B): 1061m OS reference of viewpoint: X= 347685.02 Y= 175642.633 | | | | | |
| Direction of view: 143 ^o (south east) Viewpoint height: 8.412m AOD | | | | | |
| Horizontal field of view: 120 ^o Viewing distance approx 300mm at A1 | | | | | |
| | | | | | |
| A | 19/03/2014 | FRWQ | AJG | LG | NH |
| ISSUE | DATE | COMMENTS | DRAW | CHKD | APPD |
| Title NATIONAL GRID (HINKLEY POINT C CONNECTION PROJECT) VOLUME 8.7.3 VERIFIED PHOTOMONTAGE VIEWPOINT VPF9 | | | | | |
| | | | | | |
| NSG INVESTMENT No. | APPLICATION No. | | | | IN |
| 20897 | EN020001 | | | | A1 |
| FIGURE No. | DRAWING No. | | | | SCALE |
| 8.7.3.27 | IN1979.82.025.001B | | | | NTS |
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| | | | | | A |



Existing view

Existing view from PRoW LA13/45/10 across Nailsea Moor north of Nailsea, looking northeast towards the F Route and W Route across Nailsea Moor and on Tickenham Ridge and north towards the Grade I listed Church of St Quiricus and St Julietta (asset ID LB85) with Grade II* listed Tickenham Court (asset ID LB350) partially visible and Tickenham Court House which is not listed (Section F)



Anticipated view during operation

Anticipated view of the 400kV overhead line supported by T-pylons, visible across Nailsea Moor and on Tickenham Ridge during operation (with the F Route, W Route and two trees removed)

Viewing Information

This is a composite image made up of 6 No. 50mm photographs joined together horizontally to form an overall field of view which is wider than that seen in detail by the human eye.

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When not in the real landscape in order to provide an accurate representation

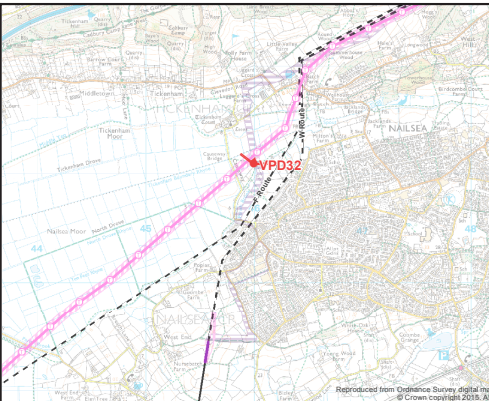

images should be viewed with one eye by panning accross a flat image with the eye remaining at the recommended viewing distance of 300mm from the image.

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Light Detection and Ranging (LIDAR) level data typically at 40 points per/ m2 and also data at 1m and 2m intervals was used for topographical information.

T-pylon

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- Insulator - light blue/grey composite material
- Twin conductor bundle

| | | | | | | | | | | | | | | | | | | | | | | | |
|--|--------------------|--|----------|--|-----------------|-----|-------|----------|------|------------|-------------|-------|----------|--------------------|-----|---|--|--------------|--|-------|--|--|---|
| Date of photograph: 24/02/2015 Lens type:50mm (digital full frame camera) | |  | | Title NATIONAL GRID (HINKLEY POINT C CONNECTION PROJECT) VOLUME 8.7.3 | | | | | | | | | | | | | | | | | | | |
| Distance to the nearest proposed T-tylon: 111.7m OS reference of viewpoint: X= 345991.273 Y= 171092.376 | | | | VERIFIED PHOTOMONTAGE VIEWPOINT VPD32 | | | | | | | | | | | | | | | | | | | |
| Direction of view: 17.7 ^o (north east) Viewpoint height: 6.398m AOD | | | |  <small>National Grid plc, Worsley Technology Park, Worsley Rd, Worsley, Greater Manchester, M28 9PL</small> | | | | | | | | | | | | | | | | | | | |
| Horizontal field of view: 140 ^o Viewing distance approx 300mm at A1 | | <table><tr><td>NG INVESTMENT No.</td><td>APPLICATION No.</td><td>IN</td></tr><tr><td>20897</td><td>EN020001</td><td>A1</td></tr></table> <table><tr><td>FIGURE No.</td><td>DRAWING No.</td><td>SCALE</td></tr><tr><td>8.7.3.28</td><td>IN1979.82.025.001B</td><td>NTS</td></tr></table> | | NG INVESTMENT No. | APPLICATION No. | IN | 20897 | EN020001 | A1 | FIGURE No. | DRAWING No. | SCALE | 8.7.3.28 | IN1979.82.025.001B | NTS | <table><tr><td colspan="2">SHEET 1 OF 1</td><td>ISSUE</td></tr><tr><td colspan="2"></td><td>A</td></tr></table> | | SHEET 1 OF 1 | | ISSUE | | | A |
| NG INVESTMENT No. | APPLICATION No. | IN | | | | | | | | | | | | | | | | | | | | | |
| 20897 | EN020001 | A1 | | | | | | | | | | | | | | | | | | | | | |
| FIGURE No. | DRAWING No. | SCALE | | | | | | | | | | | | | | | | | | | | | |
| 8.7.3.28 | IN1979.82.025.001B | NTS | | | | | | | | | | | | | | | | | | | | | |
| SHEET 1 OF 1 | | ISSUE | | | | | | | | | | | | | | | | | | | | | |
| | | A | | | | | | | | | | | | | | | | | | | | | |
| <table><tr><td>A</td><td>19/02/16</td><td>FRWD</td><td>A/JG</td><td>L/G</td><td>NH</td></tr><tr><td>ISSUE</td><td>DATE</td><td>COMMENTS</td><td>DRAW</td><td>CHKD</td><td>APPD</td></tr></table> | | A | 19/02/16 | FRWD | A/JG | L/G | NH | ISSUE | DATE | COMMENTS | DRAW | CHKD | APPD | | | | | | | | | | |
| A | 19/02/16 | FRWD | A/JG | L/G | NH | | | | | | | | | | | | | | | | | | |
| ISSUE | DATE | COMMENTS | DRAW | CHKD | APPD | | | | | | | | | | | | | | | | | | |